



Rhino-Stop has been assessed to exceed the 30kN impact load as described in AS/NZS 1170.1 clause 3.8 a) i) for Light Traffic Areas, based on:

- Post spacing at Maximum 2 mtrs Centres
- Minimum 3 Post Assembly per Installation


REVISIONS				
REV.	ZONE	DESCRIPTION	DATE	APPV'D
A		Original Issue, supersedes GR-WB-031	04/05/2022	HW

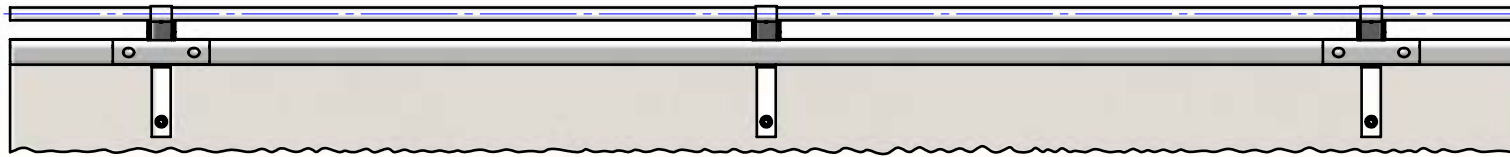


PLAN VIEW

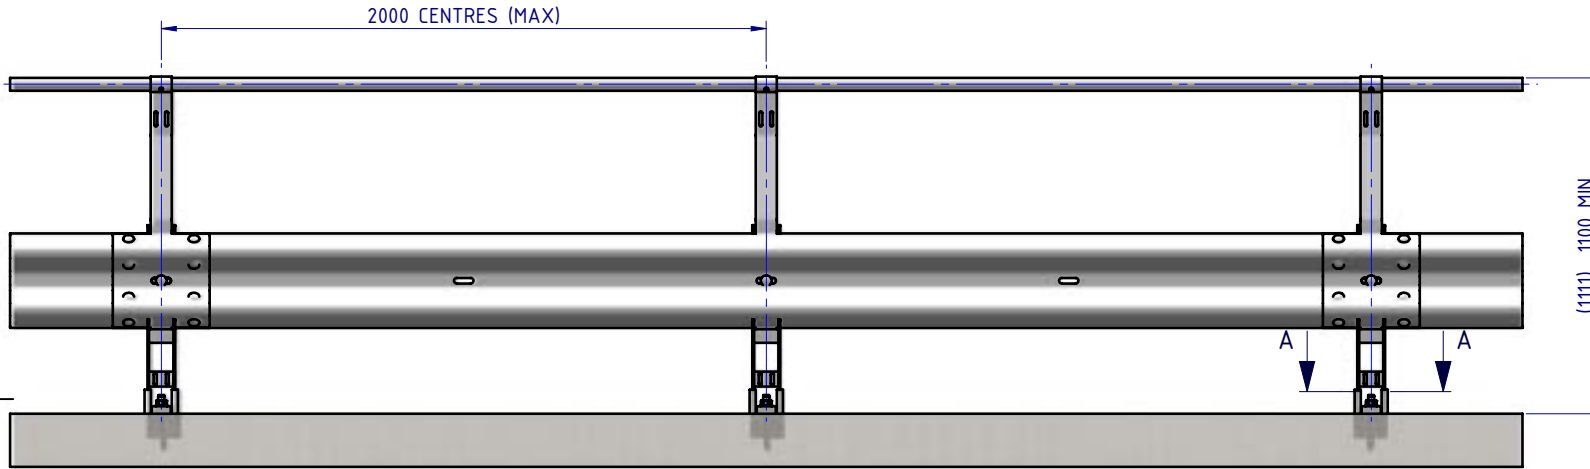

FRONT ELEVATION

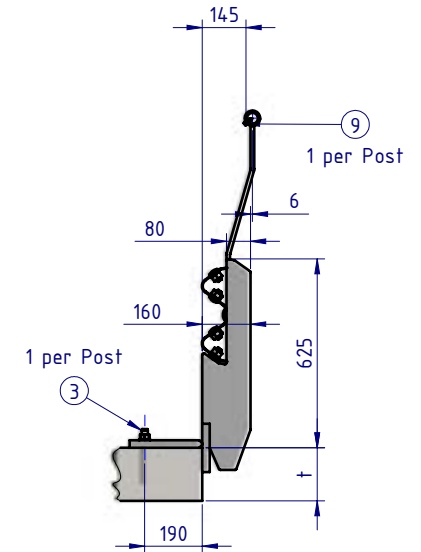

SIDE ELEVATION

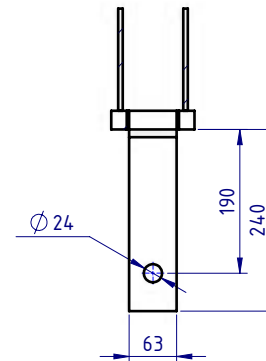

SECTION A-A  
BASE PLATE DETAIL  
SCALE 1:10

Post Anchor Bolt Installation Details		
Slab Thickness (t)	≤ 170mm	> 170mm
Anchor Bolt Part #	GR-FS-20-0160-HG	GR-FS-20-0187-HG
Anchor Bolt Type	Fischer FBN II Mechanical	Fischer FBN II Mechanical
Min. Embedment Depth	100mm	130mm
Drill Type	Masonry Bit	Masonry Bit
Drill diameter	Ø20mm	Ø20mm
Drill Depth	105mm	135mm
Minimum Torque	200Nm	200Nm

BOM			
ITEM NO.	PART NUMBER	DESCRIPTION	Weight kg
1	GR-PB-IS-0700-AG	Rhino-Stop® Sky Edge Post	13.7
2	GR-MX-MX-0800-AG	Handrail Extension Type 4	5.3
3	GR-FS-20-0187-HG	FISCHER FBN II, M20x187mm	0.5
4	GR-WB-SR-4000-CG	W-Beam Guardrail 4.0M NLL, 1.0M CTRS	43.3
5	HR-PI-32-6500-AG	Handrail / Sight Rail Pipe 32NB	20.1
6	GR-FS-16-0045-HG	M16x45 Hex Head Bolt & Nut Assy	0.0
7	GR-FS-16-0032-MG	M16x32 SPLICE Hex Bolt & Oversize Nut Assy	0.2
8	GR-FS-16-0050-MG	M16x50 POST Hex Bolt & Nut Assy	0.2
9	GR-FS-14-0025-TG	14g x 25mm Hex Head Screw Self Tapping, 10 tpi, Class5, B8 Coating	

MATERIAL:		
FINISH:		
STATUS	NAME	DATE
DRAWN	W. Rogulski	21/04/2022
CHK'D	T. Colquhoun	4/05/2022
APPV'D	H. Wallace	04/05/2022

**SafeDirection**  
CRASH BARRIER SOLUTIONS

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U.N.O: TOLERANCES: ±1mm  
ALL DIMENSIONS ARE IN: mm

**APPROVED**

TITLE: Carpark Barriers - RhinoStop® Sky-Edge Rhino-Stop® Sky-Edge Type 2 GuardRail & Offside Balustrade General Arrangement			
DWG NO. SD-CP-02002	REVISION: A	SHEET SIZE: A4	
WEIGHT: 384.4kg	DO NOT SCALE DRAWING	SCALE: 1:25	SHEET 1 of 3

Rhino-Stop has been assessed to exceed the 30kN impact load as described in AS/NZS 1170.1 clause 3.8 a) i) for Light Traffic Areas, based on:

- Post spacing at Maximum 2 mtrs Centres
- Minimum 3 Post Assembly per Installation

A

B

C


D

A

B


C

D

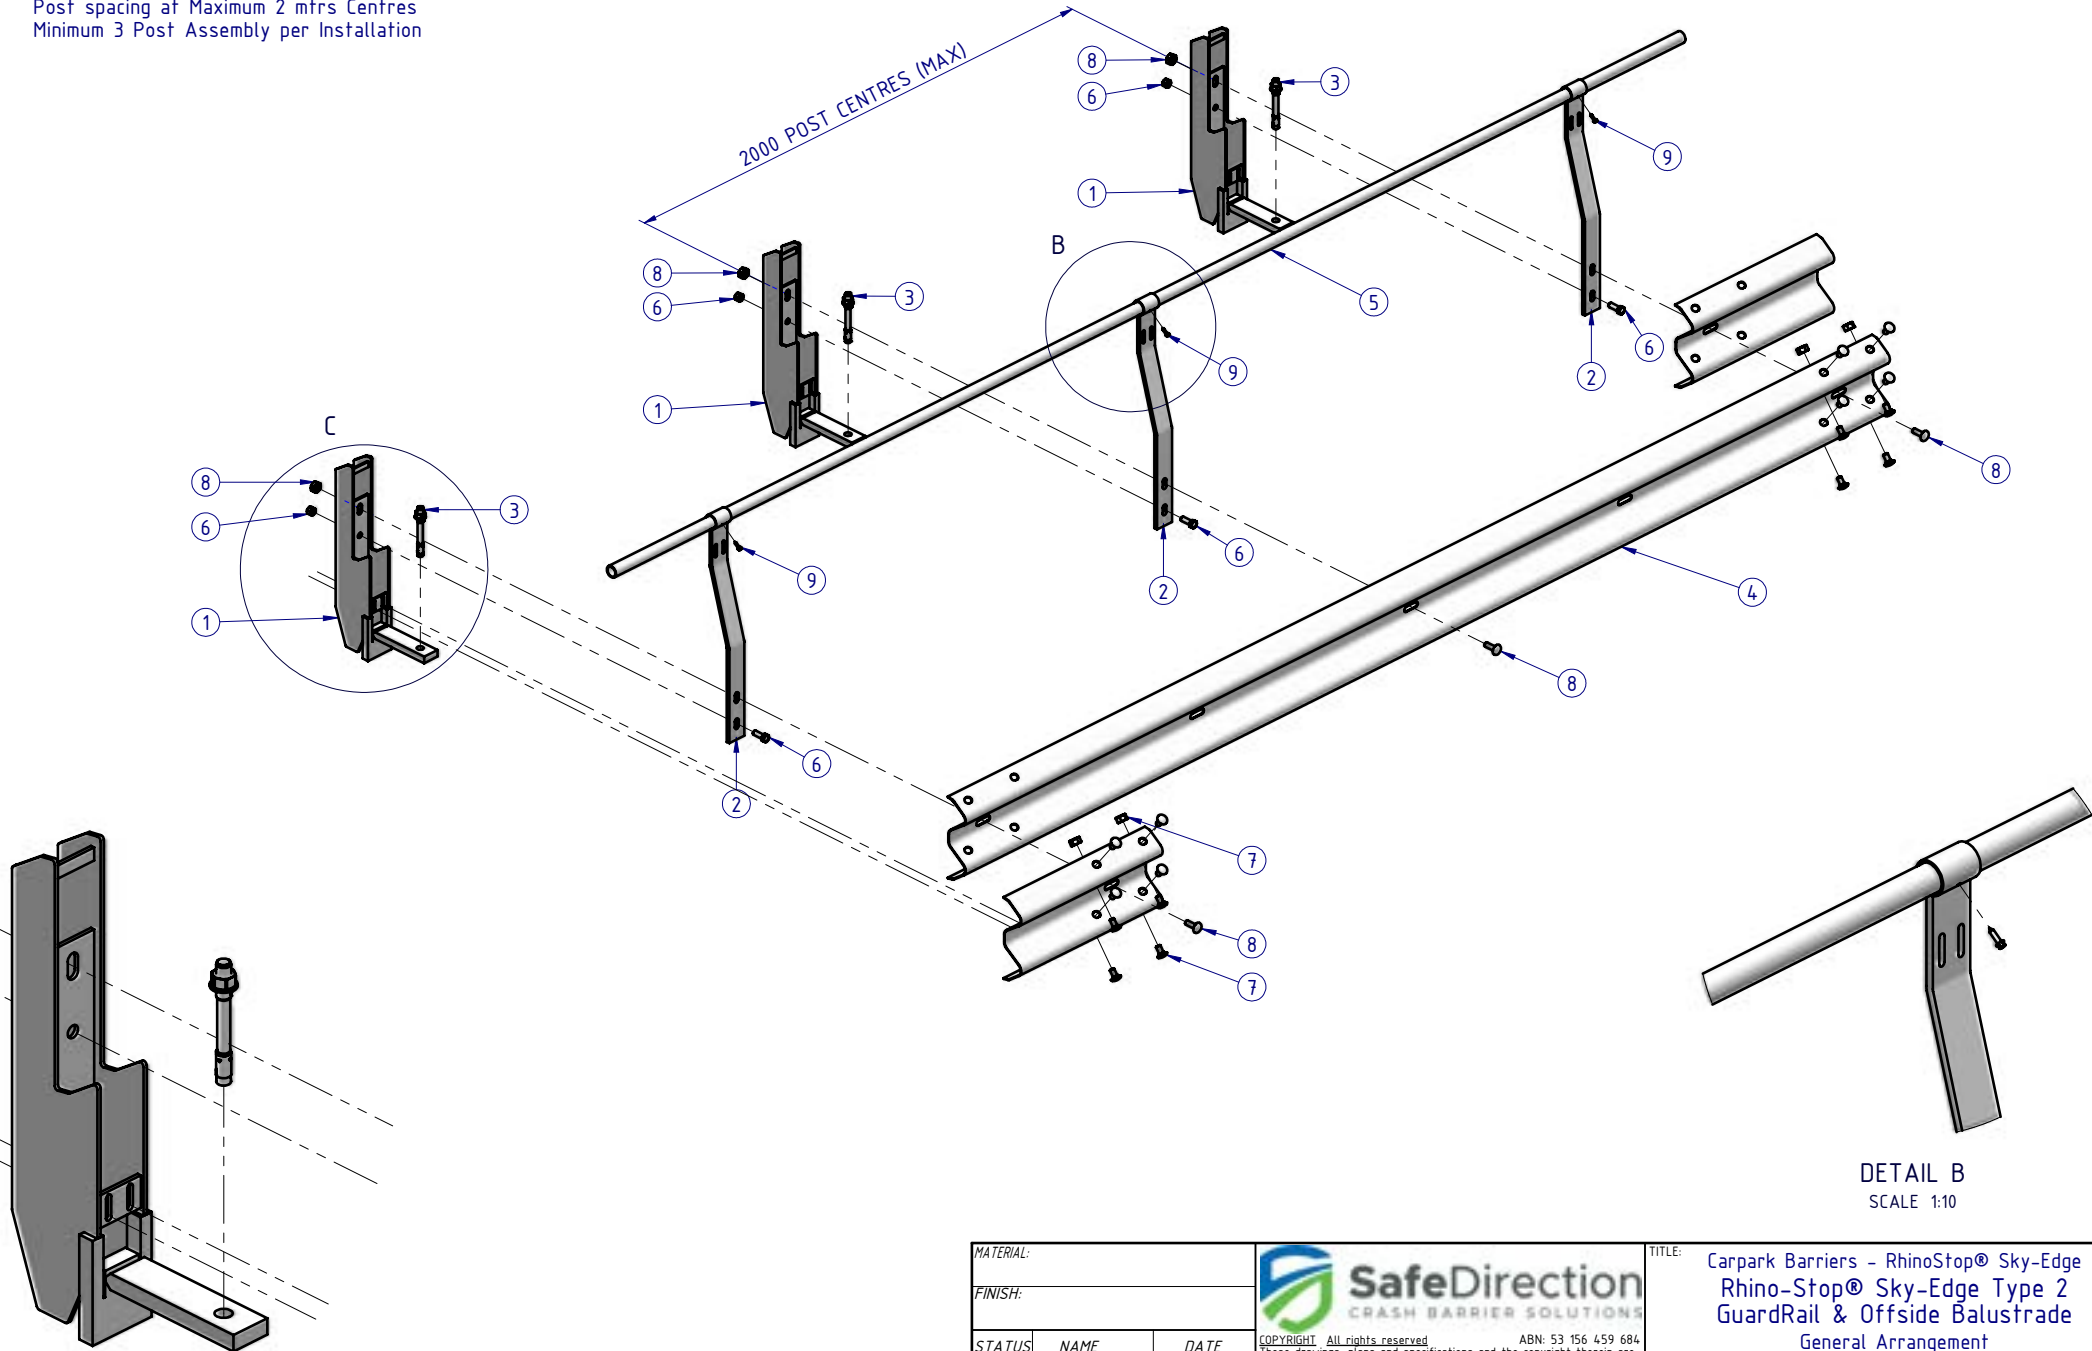


DETAIL C  
SCALE 1:10

DETAIL B  
SCALE 1:10

MATERIAL:			 <p><b>SafeDirection</b> CRASH BARRIER SOLUTIONS</p>	TITLE: Carpark Barriers - RhinoStop® Sky-Edge Type 2 GuardRail & Offside Balustrade General Arrangement				
FINISH:				<small>ABN: 53 156 459 684</small> <small>These drawings, plans and specifications and the copyright therein are the properties of Safe Direction Pty Ltd, and must not be used, reproduced or copied wholly or in part without written permission.</small>				
STATUS	NAME	DATE	<small>U.N.O. TOLERANCES: ±1mm</small> <small>ALL DIMENSIONS ARE IN: mm</small>			DWG NO. SD-CP-02002	REVISION: A	SHEET SIZE: A4
DRAWN	W. Rogulski	21/04/2022	<small>THIRD ANGLE PROJECTION</small>			WEIGHT: 384.4kg	SCALE: 1:25	SHEET 2 of 3
CHK'D	T. Colquhoun	4/05/2022	<p><b>APPROVED</b></p>			<small>DO NOT SCALE DRAWING</small>		
APPV'D	H. Wallace	04/05/2022	<small>STATUS:</small>					

Rhino-Stop has been assessed to exceed the 30kN impact load as described in AS/NZS 1170.1 clause 3.8 a) i) for Light Traffic Areas, based on:

- Post spacing at Maximum 2 mtrs Centres
- Minimum 3 Post Assembly per Installation

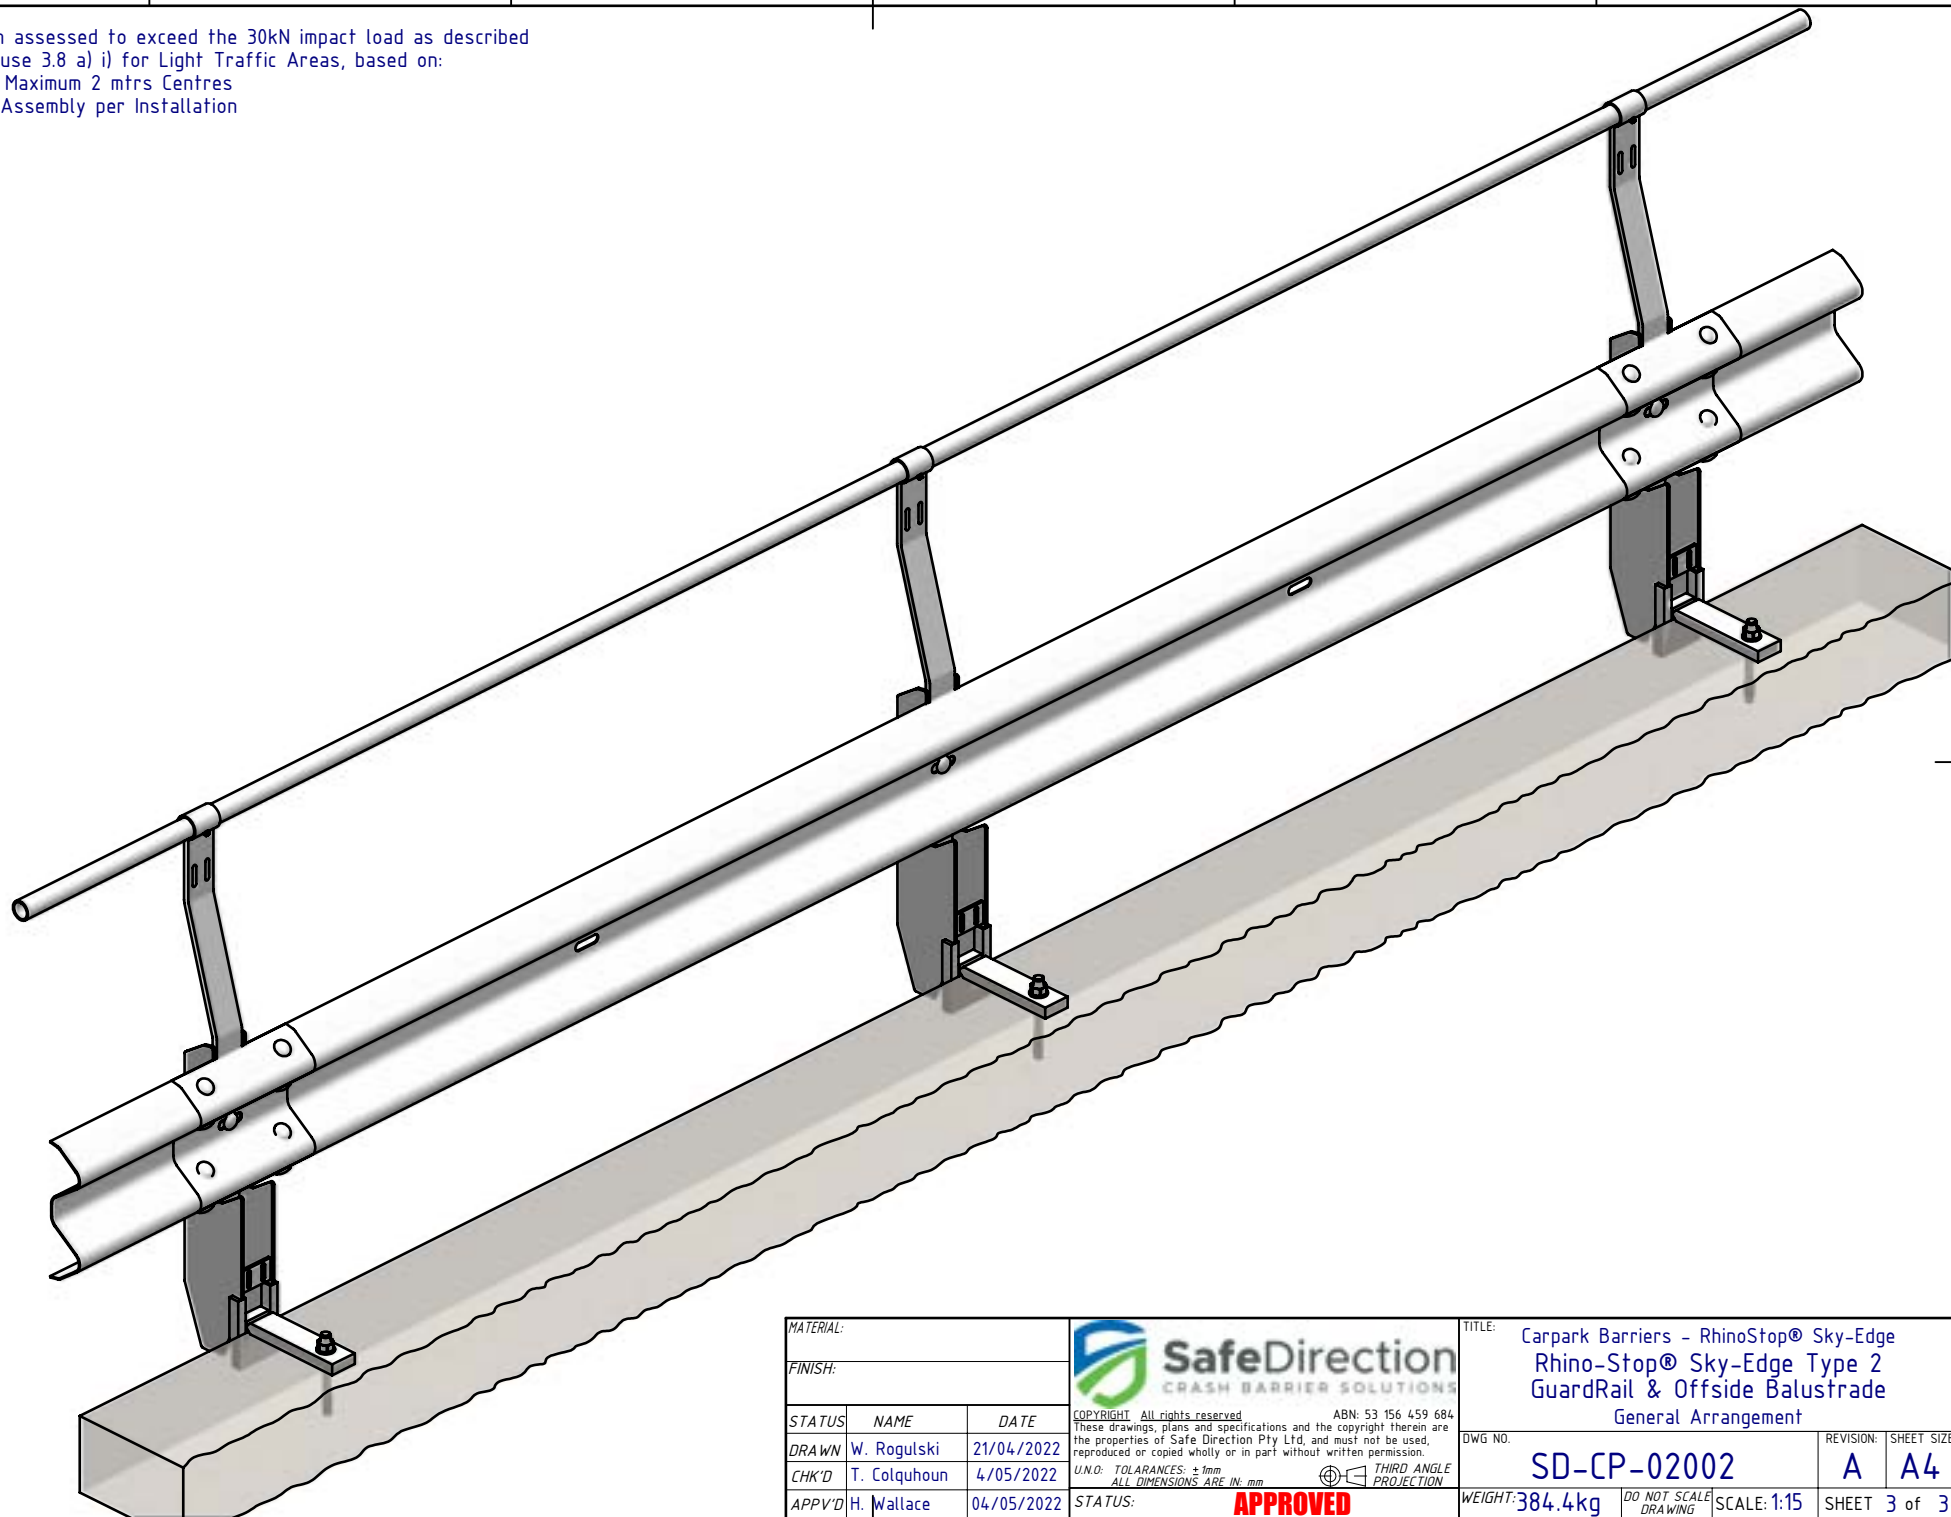

MATERIAL:		
FINISH:		
STATUS	NAME	DATE
DRAWN	W. Rogulski	21/04/2022
CHK'D	T. Colquhoun	4/05/2022
APPV'D	H. Wallace	04/05/2022

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U.N.O. TOLERANCES: ±1mm  
ALL DIMENSIONS ARE IN: mm

**APPROVED**

THIRD ANGLE PROJECTION

TITLE: Carpark Barriers - RhinoStop® Sky-Edge Type 2 GuardRail & Offside Balustrade General Arrangement		
DWG NO. SD-CP-02002	REVISION: A	SHEET SIZE: A4
WEIGHT: 384.4kg	DO NOT SCALE DRAWING	SCALE: 1:15
STATUS:		SHEET 3 of 3